CENTRAL CAROLINA TECHNICAL COLLEGE

BUILDING M500 LIGHTING UPGRADE

506 N. GUIGNARD DR., SUMTER, SC 29150

Issue Date/ Description: 02.14.2025 CONSTRUCTION DOCUMENTS

MPS Project No: 024198.02 Agency Review ID: H59-6343-PD

OWNER

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RMF ENGINEERING 194 SEVEN FARMS DRIVE CHARLESTON, SC 29492 803.254.6302 CHRIS.MORSE@BGAINC.COM CHRIS MORSE


DRAWING LIST

SHEET NO	SHEET NAME
G001	COVER SHEET
E110	LEVEL 01 - OVERALL PLAN - LIGHTING
E110D	LEVEL 01 - OVERALL PLAN - DEMOLITION
E120	LEVEL 02 - OVERALL PLAN - LIGHTING
E120D	LEVEL 02 - OVERALL PLAN - DEMOLITION
E001	ELECTRICAL - SCHEDULES AND DETAILS


Limit conduct of work to after business hours and weekends.

TABLE 3E CODE INFORMATION FOR ADDITIONS, ALTERATIONS, OR CHANGE OF OCCUPANCY TO AN EXISTING STRUCTURE TYPE OF PROJECT: Alteration (IEBC Chaps. 7, 8 & 9) Addition (IEBC Chap. 11) Change of Occupancy (IEBC Chap. 10) METHOD OF COMPLIANCE: Option 1: Prescriptive Compliance Method (IEBC Chapter 5) under that Option.) Alteration Level 1, minor including reroofing (IEBC Chap. 7) ☐ Alteration Level 2, reconfigurations of space (IEBC Chap. 8) ☐ Alteration Level 3, work area exceeds 50% (IEBC Chap. 9) Aggregate area of building: _ Option 3: Performance Compliance Method (IEBC Chap. 13) CONSTRUCTION CLASSIFICATION (IBC 602) Type: IV Change of Occupancy: Existing Occupancy Classification(s): <u>BUSINESS</u> New Occupancy Classification(s): Original Building Code and Edition Applicable at time of Construction: SBC 1982 Provisions for Accessibility Required (IEBC 306)? ⊠ No Existing Sprinkler System? Yes Yes X Auto ☐ Manual Existing Fire Alarm System? ⊠ No Seismic Evaluation Required? Yes Yes Major Facility Project? (See §48-52-810(10)(a)) ⊠ No Historic Building (IEBC Chapter 12): Reconstruction Preservation Restoration

AREA MAP

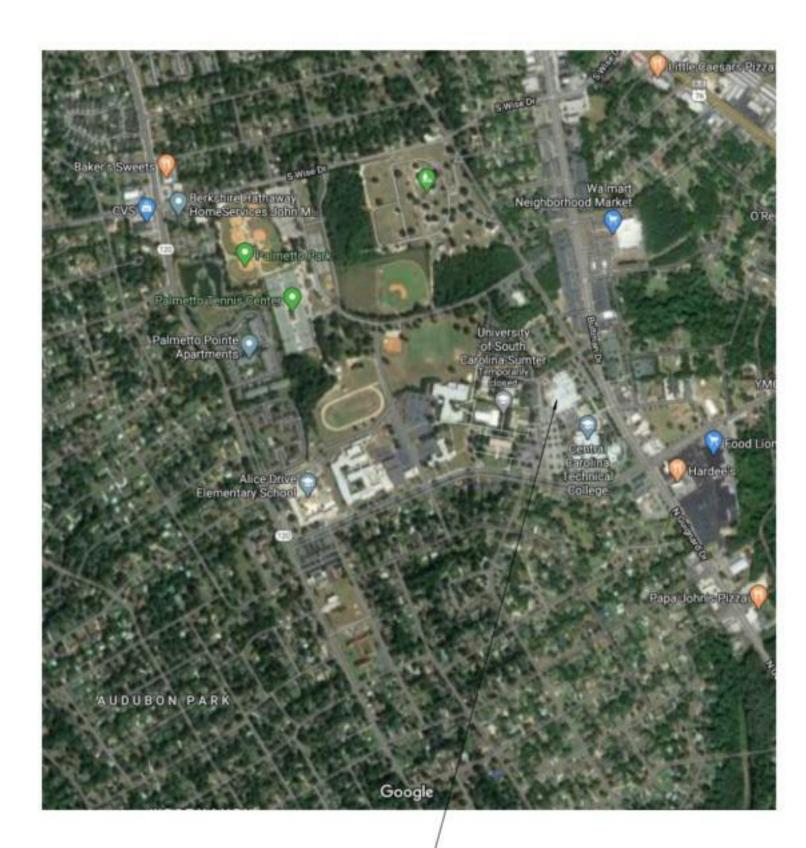

SITE MAP

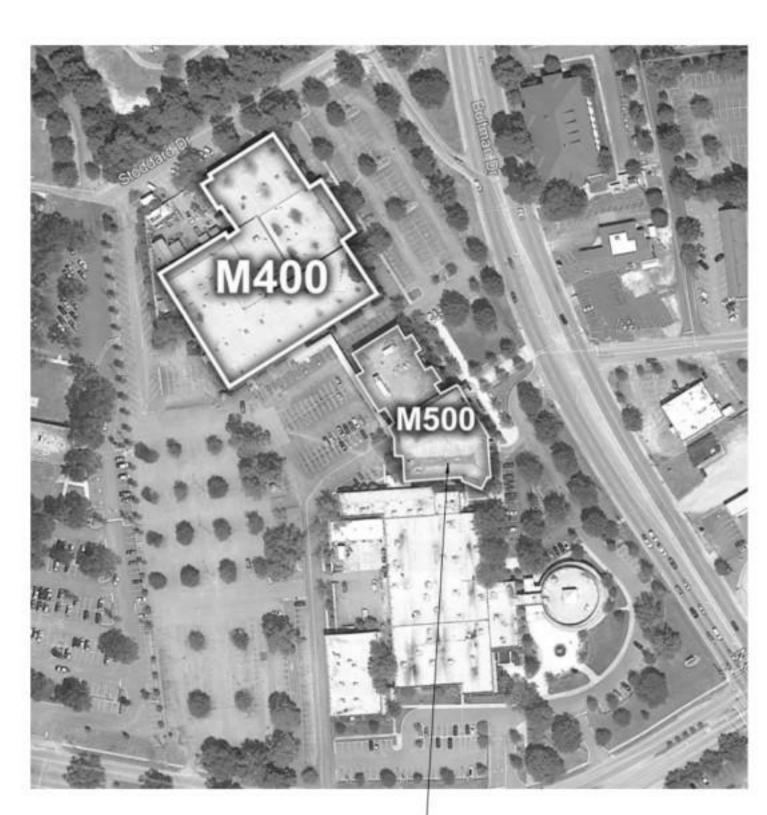



PROJECT SITE
BUILDING M500

PROJECT SITE

506 N. GUIGNARD DR.

PROJECT SITE

mcmillan pazdan smith ARCHITECTURE

CONSULTANT LOGO

DING M500 LIGHTING UPGRADE

ISSUE DATE: 09/04/2024
PHASE: 00 NOT SET
SHEET ISSUE:

0 02.14.2025 CONSTRUCTION DOCUMENTS

NO. DATE DESCRIPTION

PRINCIPAL IN CHARGE:
PROJECT ARCHITECT:
DRAWN BY:
SHEET TITLE:

COVER SHEET

SHEET NO

PROJ. NO. 024198.02

		LIGH	TING FIX	TURE S	SCHE	DULE		
TYPE	MANUFACTURER	PART NUMBER	FINISH	LAMP QUANTITY	LAMP TYPE	WATTAGE	VOLTAGE	REMARKS
А	LITHONIA LITETRONICS DAYBRITE	CPX 2X2 ALO7 SWW7 M4 EQUAL EQUAL	WHITE	-	LED	30	UNV	2'x2' BACKLIT FLATPANEL, SWITCHABLE LUMEN OUTPUT AND COLOR TEMPERATURE TROFFER WITH GRID TRIM. PROVIDE WITH 10 YEAR WARRANTY
В	LITHONIA LITETRONICS DAYBRITE	CPX 2X4 ALO8 SWW7 M2 EQUAL EQUAL	WHITE	-	LED	38	UNV	2'x4' BACKLIT FLATPANEL, SWITCHABLE LUMEN OUTPUT AND COLOR TEMPERATURE TROFFER WITH GRID TRIM. PROVIDE WITH 10 YEAR WARRANTY
F1	AXIS FINELITE LITECONTROL	B6WDLED-12-80-40-SO-4-W-UNV-1-B-D EQUAL EQUAL	FINISH BY ARCHITECT	-	LED	21	UNV	LED 4000 LUMEN LINEAR WALLMOUNT, WITH DIFFUSE LENS
M1	GOTHAM INTENSE PRESCOLITE H.E. WILLIAMS	EVO-AR-MD-LSS-GZ1 GDDR-D101-FL-SF LTR-RD-H-DM1-WD-SS-WT DR-TL-DIM1-O-M-OF-CS	-	-	LED	20	UNV	6" ROUND LED OPEN DOWNLIGHT, 2000 LUMEN, CONTRACTOR TO CONFIRM EXISTING DOWNLIGH APERTURE SIZE PRIOR TO PURCHASING OF FIXTURE PACKAGE
MVV	GOTHAM INTENSE PRESCOLITE H.E. WILLIAMS	EVO-AR-MD-LSS-GZ1 GDDR-D101-FL-SF LTR-RD-H-DM1-WD-SS-WT DR-TL-DIM1-O-M-OF-CS	-	-	LED	20	UNV	6" ROUND LED OPEN DOWNLIGHT, 2000 LUMENS WALL WASH DISTRIBUTION, CONTRACTOR TO CONFIRM EXISTING FIXTURE APERTURE SIZE PRIOR TO PURCHASING FIXTURE PACKAGE
N	H.E. WILLIAMS ECLIPSE KENALL	AVX-4-WPC-DIM-UNV 574-SPL-LED-UNV-D7A MLHA8-4-R-PP-DV	WHITE.PAINT AFTER FAB.	-	LED	57	UNV	4' LED, 4500 LUMEN SURFACE MOUNT, VANDAL-RESISTANT WHITE POLYCARBONATE LEI FIXTURE.
Q	H.E. WILLIAMS COLUMBIA LITHONIA	75S-4-UNV MPS-4-C-W-E-U ZL1N-L48-FST-MVOLT-WH	WHITE / PAINT AFTER FABRICATION	-	LED	55	UNV	4' LED 5000 LUMEN CHAIN HUNG STRIP, LENSED
R2	EXISTING	-	-	2	T8 LED	14	UNV	EXISTING 2 LAMP LINEAR FLUORESCENT PENDAN FIXTURE. REMOVE EXISTING BALLAST, BATTER' PACKS AND REWIRE TOMBSTONES AS REQUIRE RELAMP WITH LED TLED BALLAST BYPASS REPLACEMENT LAMPS. SATCO PART # 14T8/LED/48-840-DP-SE-DE, OR PRIOR APPROVE EQUAL
R4	EXISTING	-	-	4	T8 LED	14	UNV	EXISTING 4 LAMP LINEAR FLUORESCENT PENDAN FIXTURE. REMOVE EXISTING BALLAST, BATTER' PACKS AND REWIRE TOMBSTONES AS REQUIRE RELAMP WITH LED TLED BALLAST BYPASS REPLACEMENT LAMPS. SATCO PART # 14T8/LED/48-840-DP-SE-DE, OR PRIOR APPROVE EQUAL
W1	LSI HUBBELL LITHONIA PIL NLS	XWS-LED-2L-MTPD-UNV LNC2-9L070-3-U ARC1LED-P2-MVOLT-FAO SH1-13.5-80-UNV-NA NV-W-T3	FINISH BY ARCHITECT	-	LED	21	UNV	LED 2000 LUMEN WALL MOUNT FULL CUTOFF WA PACK, WITH DIFFUSE LENS, TYPE III DISTRIBUTIO
WM	GOTHAM INTENSE PRESCOLITE H.E. WILLIAMS	EVO-AR-MD-LSS-GZ1 GDDR-D101-FL-SF LTR-RD-H-DM1-WD-SS-WT DR-TL-DIM1-O-M-OF-CS	-	-	LED	20	UNV	6" ROUND LED OPEN DOWNLIGHT, 3000 LUMENS WET LOCATION LISTED, CONTRACTOR TO CONFIF EXISTING FIXTURE APERTURE SIZE PRIOR TO PURCHASING FIXTURE PACKAGE.
EM	LITHONIA	ELM2L-LTP	WHITE	-	LED	-	UNV	DUAL HEAD EMERGENCY LIGHT, WALLMOUNT.
EX1	INFINITY SURE-LITES LITHONIA LIGHTALARMS ABB	EXIT/CA-SF-R-EM-WF-WH CX-6-1-R-W LES-W1R-120/277-ELN 1-XDND-W-RW WW-TXN-1-R	WHITE	BY MANF.	LED	-	UNV	SINGLE FACED LED, EVENLY ILLUMINATED EXIT LIGHT WITH EMERGENCY BATTERY BACKUP.
EX2	INFINITY SURE-LITES LITHONIA LIGHTALARMS ABB	EXIT/CA-DF-R-EM-WF-WH CX-6-2-R-W LES-W2R-120/277-ELN 2-XDND-W-RW WW-TXN-2-R	WHITE	BY MANF.	LED	-	UNV	DOUBLE FACED LED, EVENLY ILLUMINATED EXI- LIGHT WITH EMERGENCY BATTERY BACKUP.

LIGHTING FIXTURE SCHEDULE


- 1. THE CONTRACTOR SHALL BE RESPONSIBLE FOR FURNISHING FIXTURE TRIMS THAT ARE COMPATIBLE WITH CEILING TYPES SHOWN ON THE REFLECTED CEILING PLANS, REGARDLESS OF THE FIXTURE TRIMS INDICATED IN THE FIXTURE SCHEDULE.
- 2. UNLESS NOTED OTHERWISE ON FIXTURE SCHEDULE, THE COLOR TEMPERATURE OF LIGHT SOURCES SHALL BE 4000K WITH MINIMUM CRI OF 80.
- 3. PROVIDE THE FOLLOWING SPARES:

(5) EX1 (5) EX2 (10) A

(5) EX1 (5) EX2 (10) A (5) B (5) M1 (5) Q

1 LIGHTING FIXTURE SCHEDULE

(1 L E001 N7

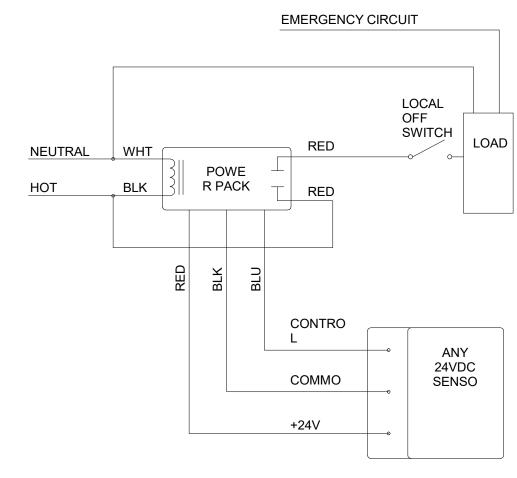

TYPICAL OCCUPANCY SENSOR WIRING DIAGRAM

EMERGENCY LIGHTING NOTES

LIGHTING FIXTURES DESIGNATED AS EMERGENCY ARE IDENTIFIED BY
THE FOLLOWING SYMBOLS AND SUFFIXES:

** = FIXTURE TYPE DESIGNATION

2. EMERGENCY FIXTURES SHALL BE FURNISHED WITH A SELF TEST BATTERY BACKUP BY IOTA OR APPROVED EQUAL, WITH A REMOTE MANUAL TEST BUTTON INSTALLED ADJACENT TO FIXTURE. FOR EXTERIOR FIXTURES TEST SWITCH SHALL BE LOCATED INSIDE NEAREST DOORWAY. PROVIDE AN UNSWITCHED FROM ROOM LIGHTING CIRCUIT TO ALL FIXTURES WITH A BATTERY BACKUP. BATTERY BACKUPS SHALL BE INSTALLED PER MANUFACTURER'S INSTALLATION INSTRUCTIONS.

3. NIGHT LIGHTING FIXTURES ARE IDENTIFIED BY THE FOLLOWING SYMBOLS:

ONL . NL . NL

4. NIGHT LIGHTING FIXTURES SHALL BE CONNECTED TO UNSWITCHED CONDUCTOR TO PROVIDE CONSTANT OPERATION.

GENERAL LIGHTING INSTALLATION NOTES:

- 1. OCCUPANCY SENSORS SHALL BE ADJUSTED AS REQUIRED FOR ROOM COVERAGE, SET TO TIME OUT AFTER 30 MINUTES AND SET TO MAXIMUM SENSITIVITY.
- COORDINATE OCCUPANCY SENSOR LOCATIONS WITH CASEWORK AND SHELVING AND EXISTING CEILING DEVICES. OCCUPANCY SENSORS SHALL NOT BE INSTALLED OVER OBJECTS THAT INTERFERE WITH THEIR OPERATION AND RANGE. SHIFT LOCATIONS AS REQUIRED FOR PROPER OPERATION AND TO ACCESS TO THE DEVICE.
- PROVIDE MINIMUM #12 AWG CONDUCTORS FOR LIGHTING BRANCH CIRCUIT OR LARGER WHERE
- ALL LOW VOLTAGE WIRING SHALL BE INSTALLED IN 3/4" CONDUIT. ALL POWER PACKS SHALL BE INSTALLED 5. IN JUNCTION BOXES. INSTALLATION SHALL COMPLY WITH MANUFACTURER'S REQUIREMENTS.
- THE CONTRACTOR SHALL PROVIDE AN UNSWITCHED CONDUCTOR TO ALL EMERGENCY FIXTURES AS 6. REQUIRED FOR EMERGENCY OPERATION. SEE EMERGENCY LIGHTING NOTES.
- ADJUST FIXTURE LOCATIONS AS REQUIRED FOR MECHANICAL EQUIPMENT, CHASES, OR OTHER 7. EQUIPMENT AS REQUIRED FOR INSTALLATION.
- 8. COORDINATE WITH OWNER TO PROVIDE 2X2 TILES, QUANTITY AS REQUIRED, TO REPLACE BROKEN OR MISSING TILES AS A RESULT OF CONSTRUCTION OR REMOVAL OF EXISTING FIXTURE.


LIGHTING SYMBOL SCHEDULE					
SYMBO	SYMBO DESCRIPTION				
A .	LIGHTING FIXTURE				
A	EMERGENCY LIGHT, SEE EMERGENCY LIGHTING NOTES				
$A\bigcirc\!\!\!\dashv$	LIGHTING FIXTURE - WALL OR BRACKET				
Θ	EXIT SIGN, CEILING MOUNTED, ARROWS AS INDICATED ON PLANS				
$\bullet\!$	EXIT SIGN, WALL MOUNTED, ARROWS AS INDICATED ON PLANS				
P	POWER PACK, WATTSTOPPER PART # BZ-150				
1	CEILING MOUNTED OCCUPANCY SENSOR, WATTSTOPPER PART # DT-355				
2	CEILING MOUNTED OCCUPANCY SENSOR, WATTSTOPPER PART # DT-300				
▼.	CEILING MOUNTED OCCUPANCY SENSOR, WATTSTOPPER PART # DT-200				
3	CEILING MOUNTED OCCUPANCY SENSOR, WATTSTOPPER PART # WT-2200				
4	CEILING MOUNTED OCCUPANCY SENSOR, WATTSTOPPER PART # WT-2250				
W	WALL SWITCH OCCUPANCY SENSOR, WATTSTOPPER PART # DW-100				
	SWITCH STATION				
S	STANDARD TOGGLE SWITCH				
S ₃	THREE WAY TOGGLE SWITCH				



CONSULTANT LOGO

Buford
Goff
& Associates, Inc.
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ING M500 LIGHTING UPGRADE

ISSUE DATE: 2/14/2025
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0 02.14.2025 CONSTRUCTION DOCUMENTS
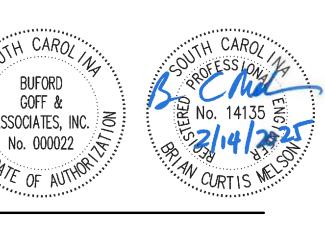
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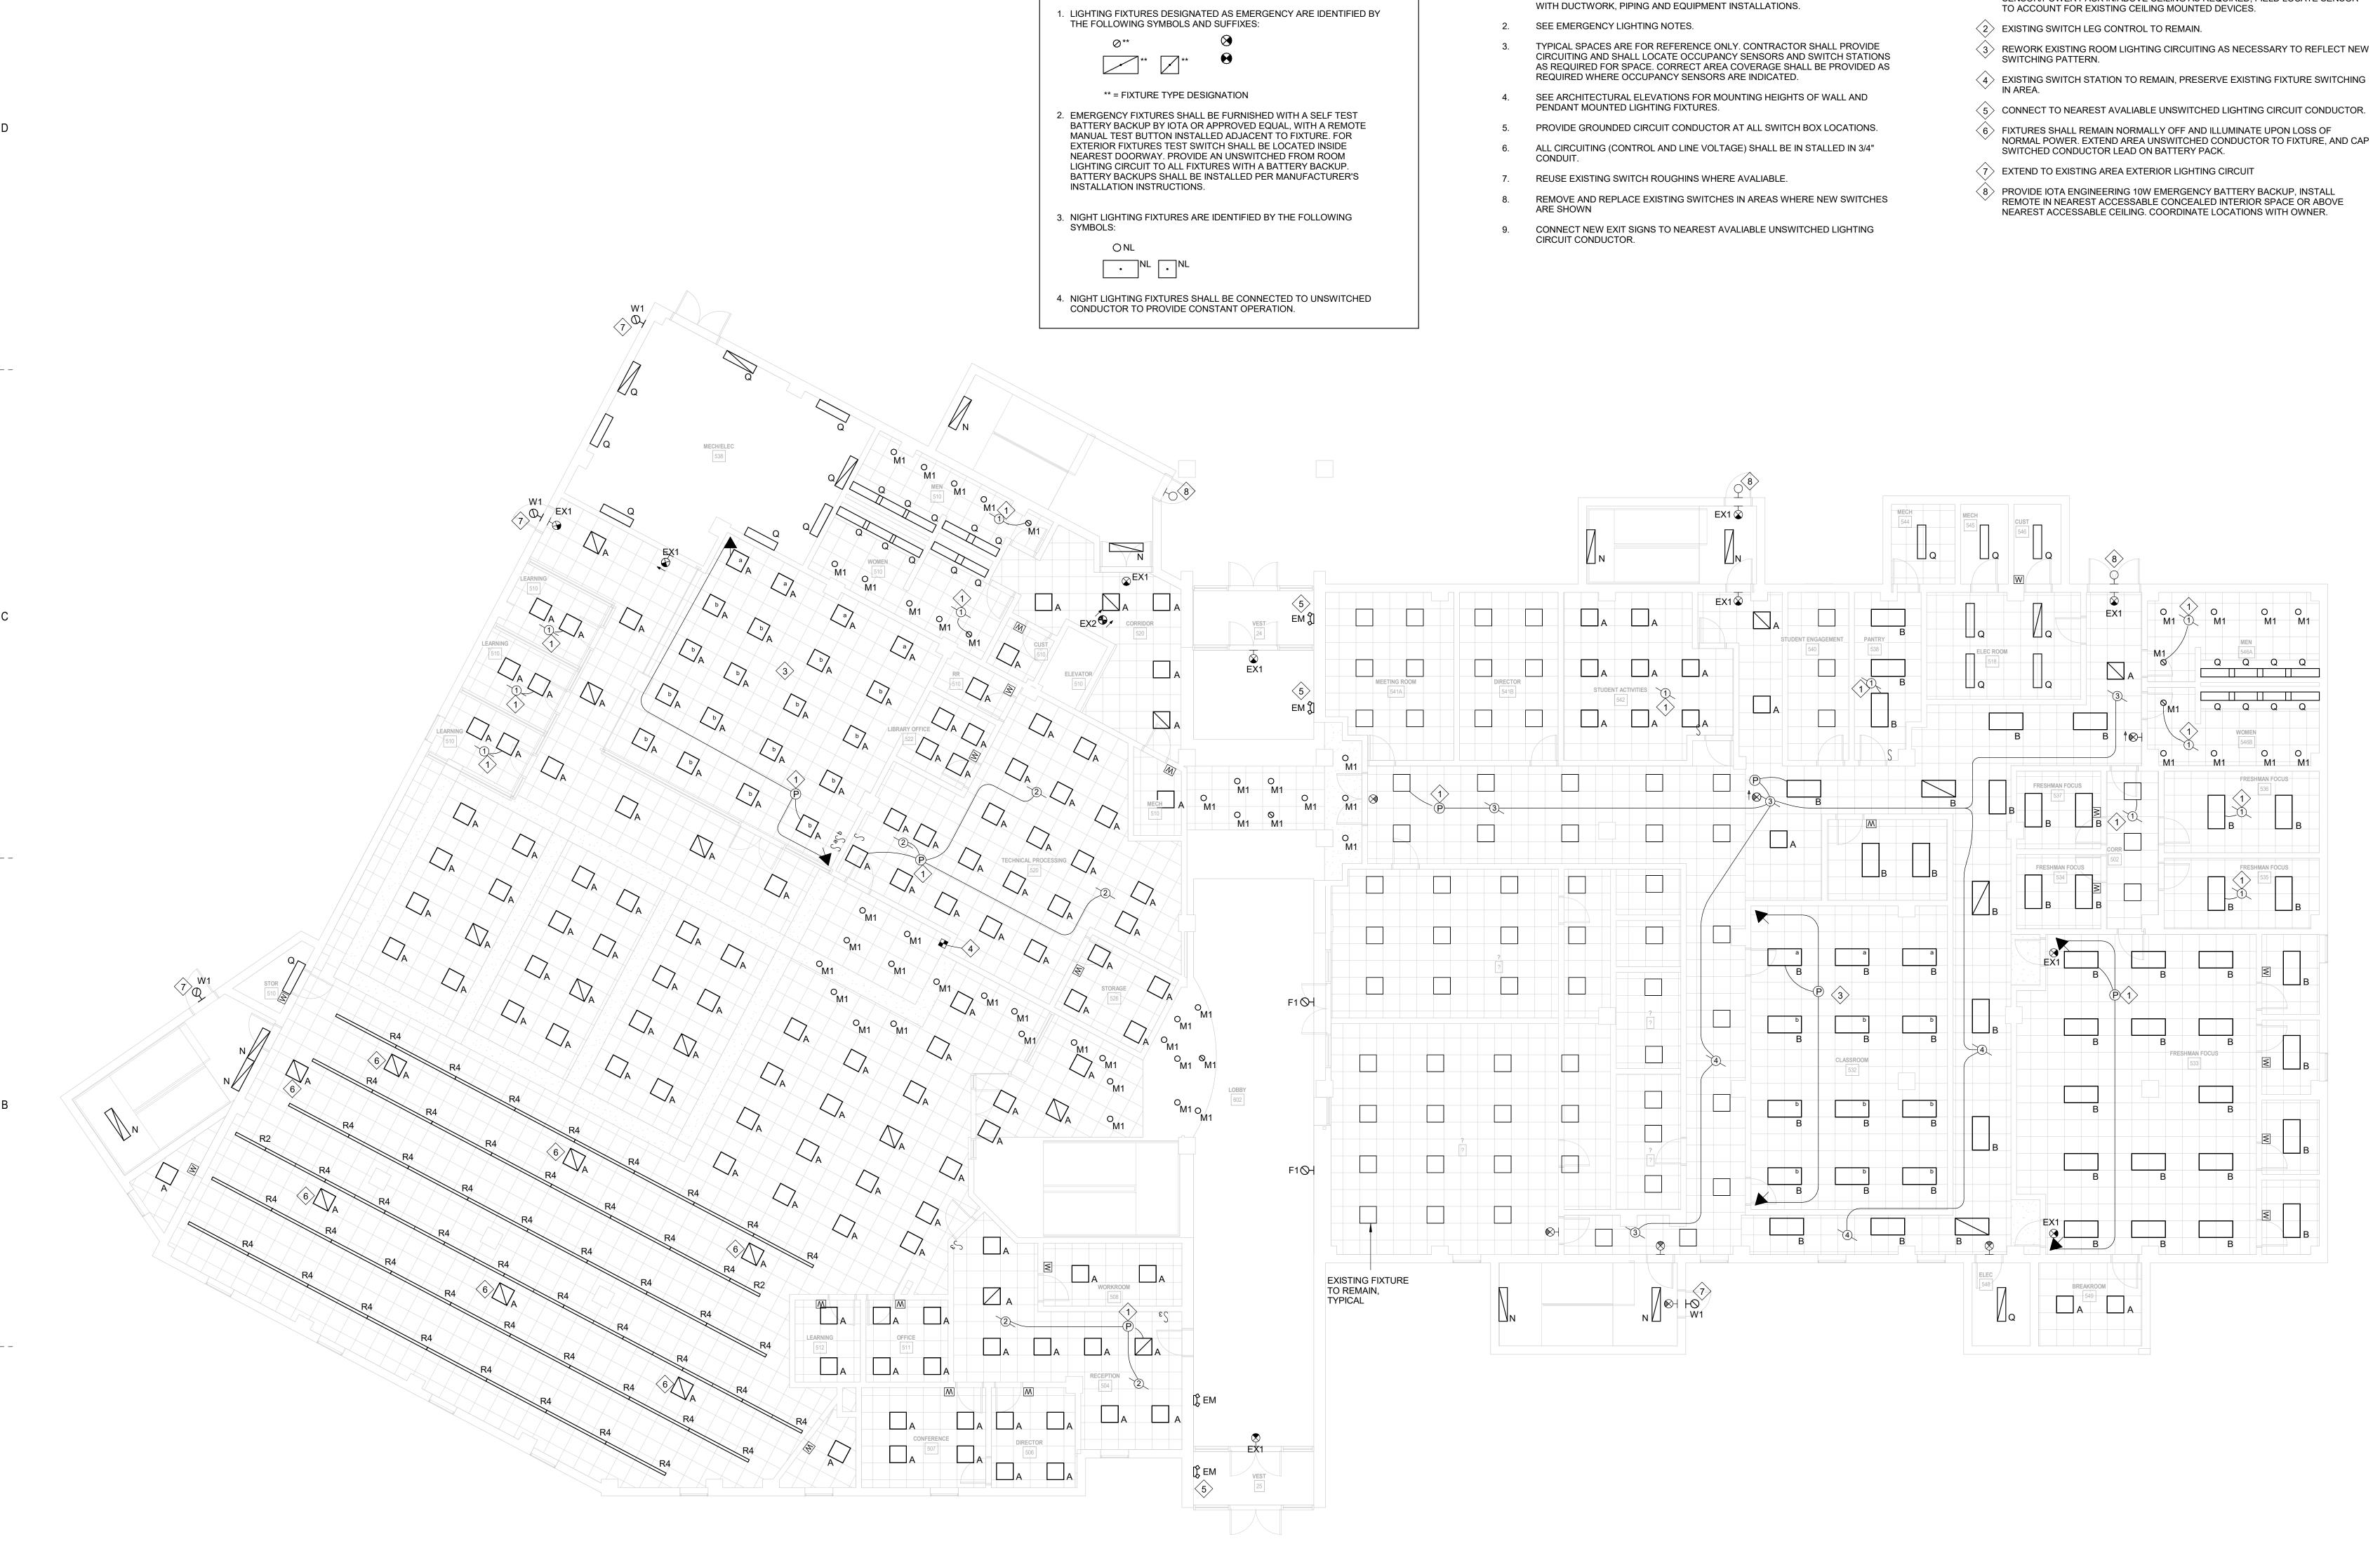
ELECTRICAL SCHEDULES AND
DETAILS

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E001



EMERGENCY LIGHTING NOTES

KEYNOTES:

GENERAL NOTES:

COORDINATE INSTALLATION OF LIGHTING FIXTURES IN MECHANICAL ROOMS

- CAPTURE ROOM LIGHTING CIRCUIT AHEAD OF SWITCH LEG. INSTALL OCCUPANCY SENSOR/POWER PACK IN/ABOVE CEILING AS REQUIRED, FIELD LOCATE SENSOR
- 4 EXISTING SWITCH STATION TO REMAIN, PRESERVE EXISTING FIXTURE SWITCHING

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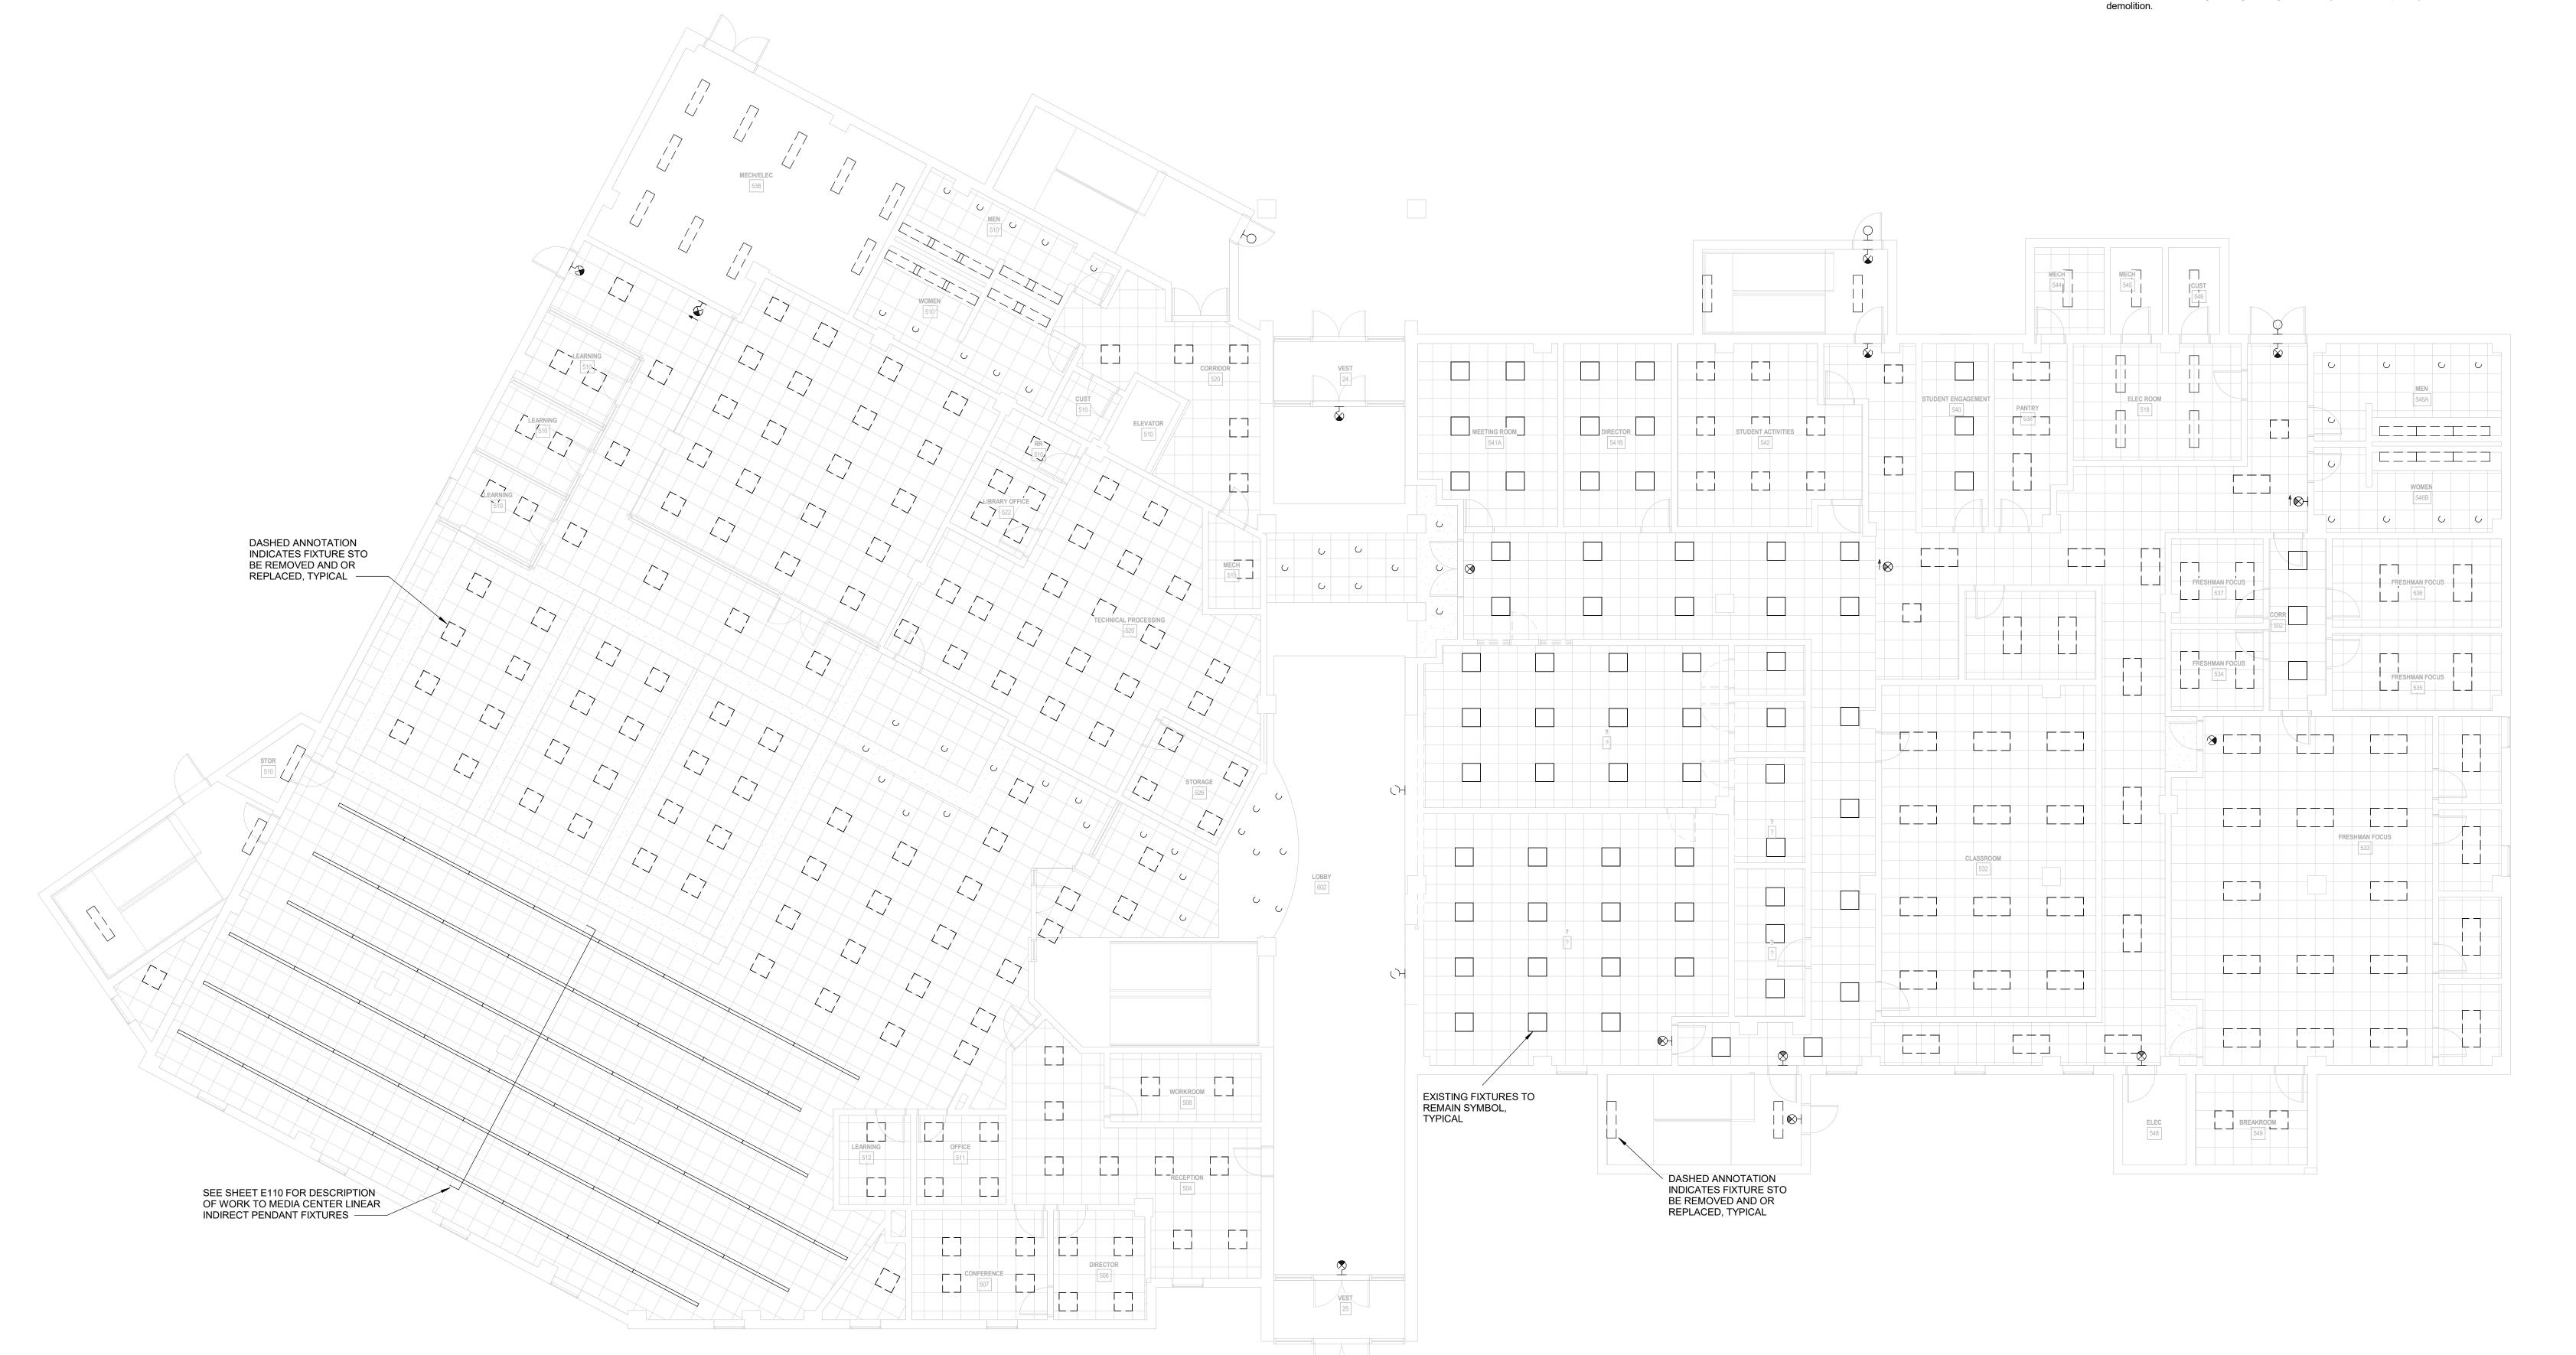
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LEVEL 01 - OVERALL PLAN - LIGHTING

024198.02

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- Demolition notes are based on casual field observations and existing record documents. Report discrepancies to architect/engineer before disturbing existing installation.
- 2. Verify field measurements and circuiting arrangements prior to commencement of work.
- 3. Coordinate outages of all building electrical systems with owner.
- Provide temporary wiring and connections to maintain all existing building electrical systems affected by demolition and renovation work.
- 5. Remove all abandoned wiring and equipment and repair finishes to match
- 6. Reconnect all remaining existing building electrical systems interrupted by



A5 LEVEL 01 - OVERALL PLAN - LIGHTING - DEMOLITION

E110D 1/8" = 1'-0"

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PROJECT NORTH

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LEVEL 01 - OVERALL PLAN - DEMOLITION

SHEET NO.

PROJ. NO. 024198.02

BCM CMM CMM

E110D

GENERAL NOTES:

- COORDINATE INSTALLATION OF LIGHTING FIXTURES IN MECHANICAL ROOMS WITH DUCTWORK, PIPING AND EQUIPMENT INSTALLATIONS.
- 2. SEE EMERGENCY LIGHTING NOTES.
- TYPICAL SPACES ARE FOR REFERENCE ONLY. CONTRACTOR SHALL PROVIDE CIRCUITING AND SHALL LOCATE OCCUPANCY SENSORS AND SWITCH STATIONS AS REQUIRED FOR SPACE. CORRECT AREA COVERAGE SHALL BE PROVIDED AS REQUIRED WHERE OCCUPANCY SENSORS ARE INDICATED.
- SEE ARCHITECTURAL ELEVATIONS FOR MOUNTING HEIGHTS OF WALL AND PENDANT MOUNTED LIGHTING FIXTURES.
- 5. PROVIDE GROUNDED CIRCUIT CONDUCTOR AT ALL SWITCH BOX LOCATIONS.
- 6. ALL CIRCUITING (CONTROL AND LINE VOLTAGE) SHALL BE IN STALLED IN 3/4" CONDUIT.
- 7. REUSE EXISTING SWITCH ROUGHINS WHERE AVALIABLE.
- REMOVE AND REPLACE EXISTING SWITCHES IN AREAS WHERE NEW SWITCHES

 ARE SHOWN
- CONNECT NEW EXIT SIGNS TO NEAREST AVALIABLE UNSWITCHED LIGHTING CIRCUIT CONDUCTOR.

- **KEYNOTES**:
- CAPTURE ROOM LIGHTING CIRCUIT AHEAD OF SWITCH LEG. INSTALL OCCUPANCY SENSOR/POWER PACK IN/ABOVE CEILING AS REQUIRED, FIELD LOCATE SENSOR TO ACCOUNT FOR EXISTING CEILING MOUNTED DEVICES.
- 2 EXISTING SWITCH LEG CONTROL TO REMAIN.
- REWORK EXISTING ROOM LIGHTING CIRCUITING AS NECESSARY TO REFLECT NEW SWITCHING PATTERN.
- EXISTING SWITCH STATION TO REMAIN, PRESERVE EXISTING FIXTURE SWITCHING IN AREA.
- CONNECT TO NEAREST AVALIABLE UNSWITCHED LIGHTING CIRCUIT CONDUCTOR.

 6 FIXTURES SHALL REMAIN NORMALLY OFF AND ILLUMINATE UPON LOSS OF NORMAL POWER. EXTEND AREA UNSWITCHED CONDUCTOR TO FIXTURE, AND CAP SWITCHED CONDUCTOR LEAD ON BATTERY PACK.
- 7> EXTEND TO EXISTING AREA EXTERIOR LIGHTING CIRCUIT
- PROVIDE IOTA ENGINEERING 10W EMERGENCY BATTERY BACKUP, INSTALL REMOTE IN NEAREST ACCESSABLE INTERIOR SPACE OR ABOVE NEAREST ACCESSABLE CEILING.

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RD ROLL SOUTH CAR



500 LIGHTING UPGRADE

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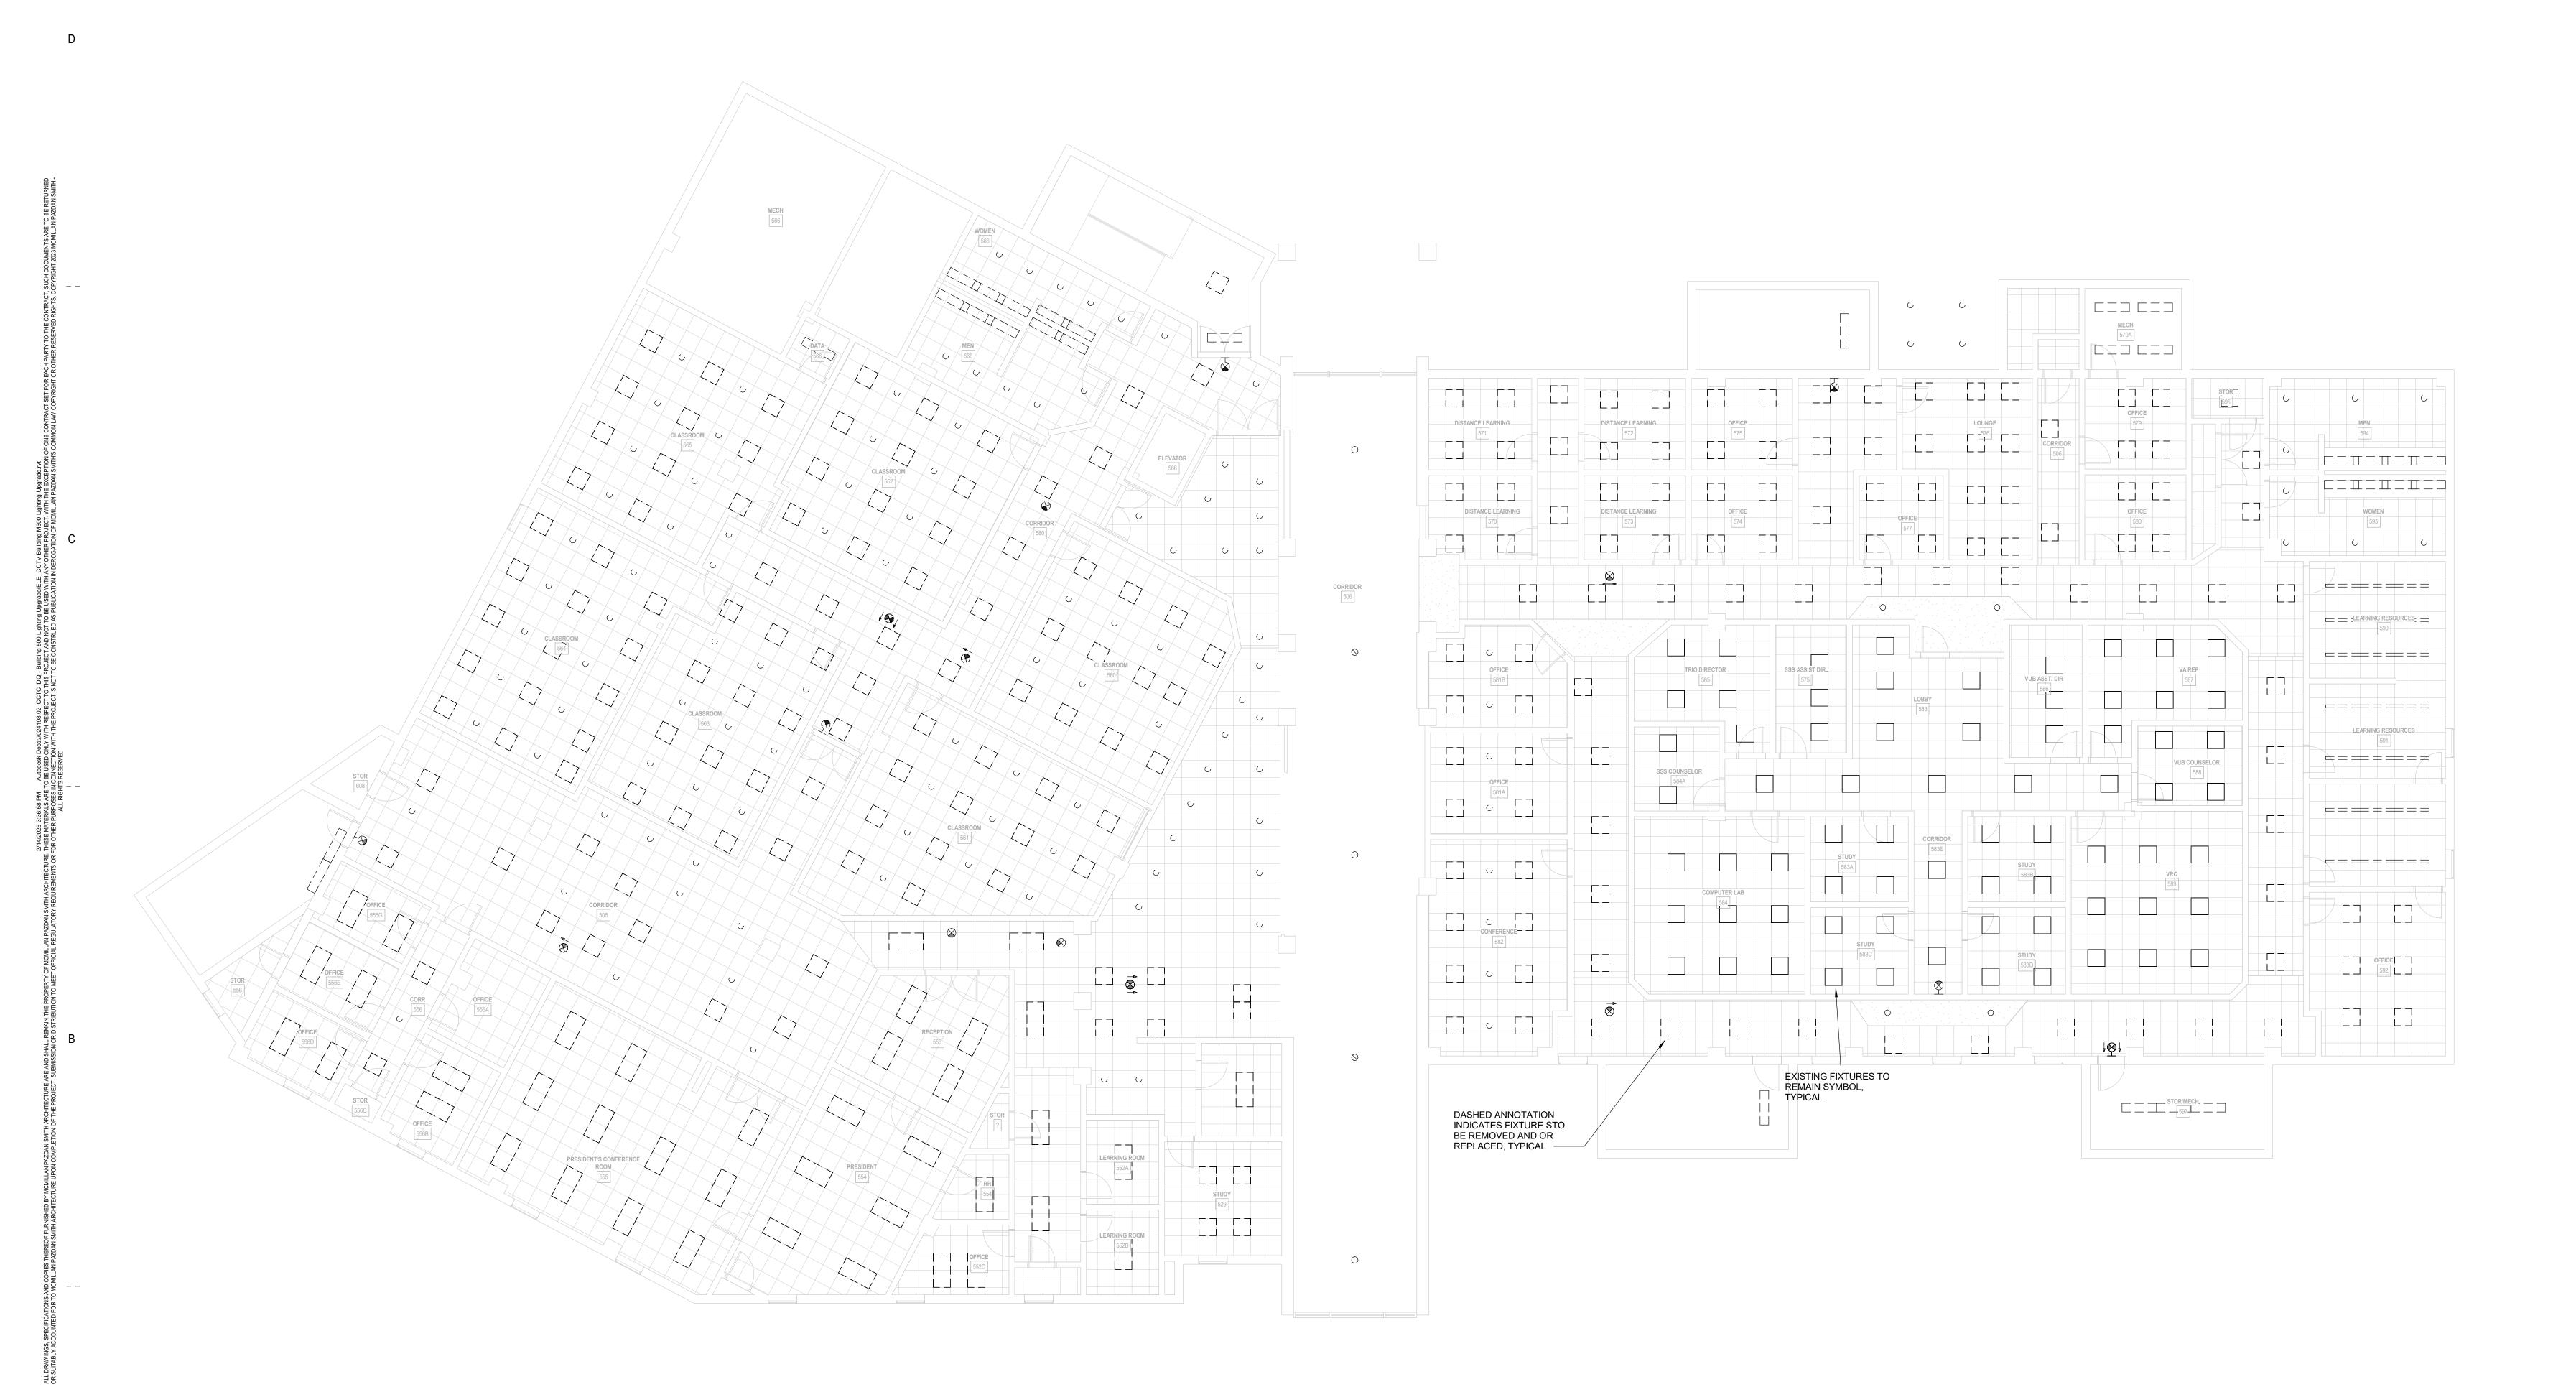
LEVEL 02 - OVERALL
PLAN - LIGHTING

024198.02

SHEET NO

E120

1 LEVEL 02 - OVERALL PLAN - LIGHTING
E120 1/8" = 1'-0"



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PRINCIPAL IN CHARGE: PROJECT ARCHITECT: LEVEL 02 - OVERALL PLAN - DEMOLITION

SHEET NO.

E120D

PROJ. NO. 024198.02

BCM CMM CMM

A5 LEVEL 02 - OVERALL PLAN - LIGHTING - DEMOLITION E120D 1/8" = 1'-0"